
# Proposed Secondary Dwelling Unit 123 ANYWHERE STREET, HAMILTON, ONTARIO

**DRAWING LIST:** Provided Survey and drawings are for Reference ONLY and are for Dwellings >5yrs in age.


A101	SAMPLE SITE PLANSAMPLE EXISTING
A102	BASEMENT PLAN SAMPLE BASEMENT
A103	PLAN - OPTION 'A' SAMPLE BASEMENT
A104	PLAN - OPTION 'B' SAMPLE GROUND
A105	FLOOR PLAN SAMPLE SECOND
A106	FLOOR PLAN
A201	SAMPLE SIDE ELEVATION
A202	SAMPLE REAR ELEVATION
A301	SAMPLE SECTIONS
A302	WALL/ CEILING DETAILS
A401	WINDOW DETAILS
A402	FIRE BLOCKING DETAILS
LINKS	Links to website

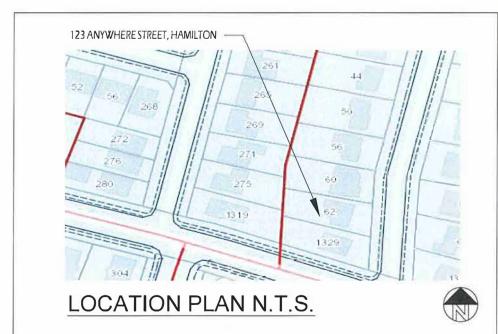

9	Location				PARKING	Length	Width		Length	Width
Ϋ́	# of Storeys	Lot Area (sqm)			Parking #1			Maneuvering Area		
Location / Parking	Front Yard (m)	Rear Yard (m)				Length	Width		Length	Width
no/	Side Yard (m)	Lot Width (m)			Parking #2			Maneuvering Area		
ati	Landscape Area (%)			-10		*				
0	Exterior Appearance A	tered: Y/N								
		TO SHOULD BE TO	-		111		Viscour.			
					Area	Ceiling Height	Window Area	Smoke Alarm	Pt.9	Pt.11 (Comp.Alt
	Living Room (min.13.5	m2 / Combined w/kitche	n(11m2)							
	Kitchen (4.2m2) /Com	bined w/ 1 bedroom Min								
Н	Dining Room (7.0m2)	combined w/other room	n (3.25m2)							
LNO	Bedroom-main (min.9.									
2	Bedroom -2 (min.7.0m	·								
	Bedroom -3 (min.7.0m									
	Bedroom -4 (min.7.0m	<del></del>								
	Ceiling Height to u/s o	f Beams/Ducts		44						
	# of Exits:	Locations:			Egress Windo	w:		Location:		
_				The state of the	A COLUMN					
					Area	Ceiling Height	Window Area	Smoke Alarm	Pt.9	Pt.11 (Comp.Alt
		m2 / Combined w/kitche		_		1				
		bined w/ 1 bedroom Min								
7		combined w/other roon	n (3.25m2)			-				
UNIT 2	Bedroom-main (min.9.					-				
	Bedroom -2 (min.7.0m							-		
	Bedroom -3 (min.7.0m	·								
	Bedroom -4 (min.7.0m									
	Ceiling Height to u/s of # of Exits:				Faces Minds			Location:		
	# OT EXITS:	Locations:		-	Egress Windo	w:		Location:	TO SHOW IN	3
			Pt.9	Pt.11				Pt.9	Pt.11	SB3
U				(Comp.Alt.)					(Comp.Alt.)	1000
FRR /STC	Egress from Dwelling U	Inits		(==://p/)	Vertical FRR r	ating				-
£	Sprinklered				Horizontal FR					
	Spmior ou						V			

NOTE: Permit Submission drawings must illustrate existing and proposed conditions including the FFR (Fire Resistant Rating) and STC (Sound Transmission Class Rating) in both wall and floor and in ceiling assembilies.




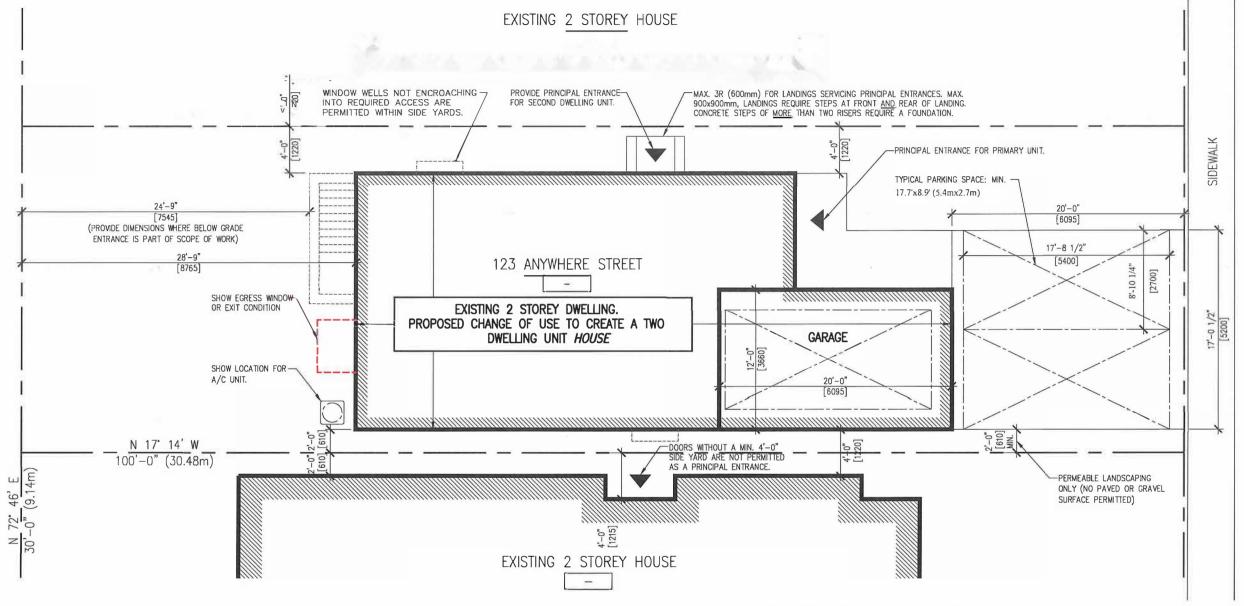


SAMPLE SITE PLAN
1/8" = 1'-0"


For Zoning and Parking regulations, visit the City of Hamilton Website (refer to links on last page)


	PROJECT NO:	A1	01
		FILE: TUDR_PLAN.DWG	
		SCALE: AS NOTED	
		DATE: AUGUST 29, 20	18
GAINT LE GITE I LAIV		CHECKED BY:	MINI
CHANGE OF USE - TWO UNIT HOUSE SAMPLE SITE PLAN		DRAWN BY: DG	# COMPLETE
PROJECT:		DESIGN BY: DG	DATE:

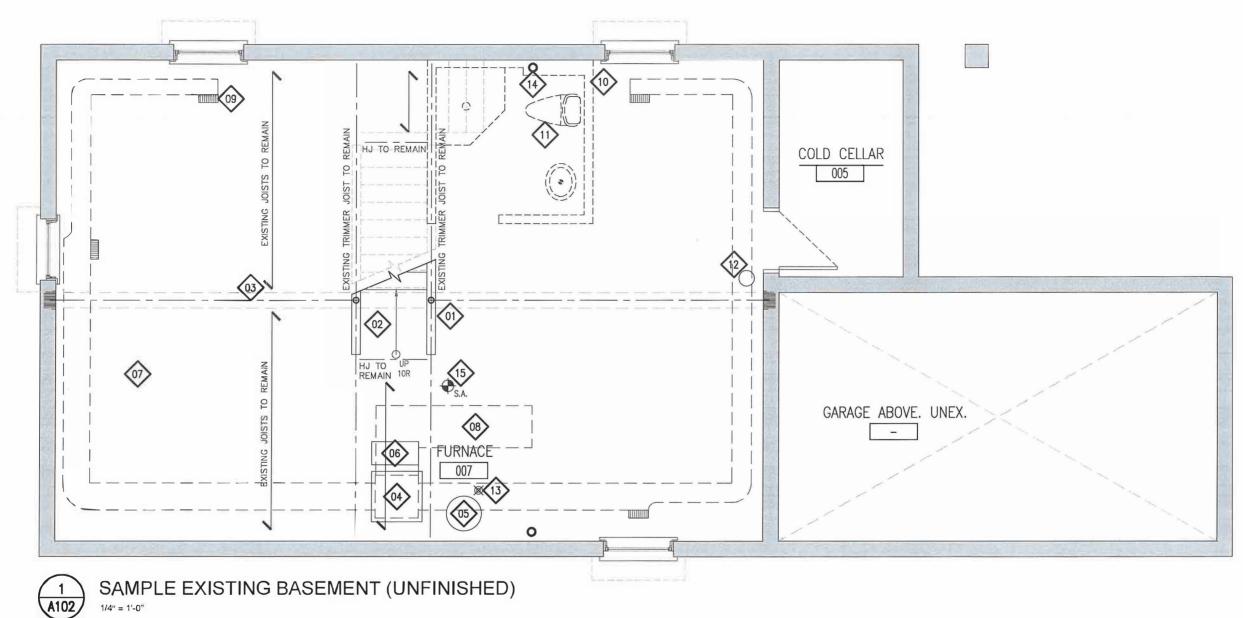


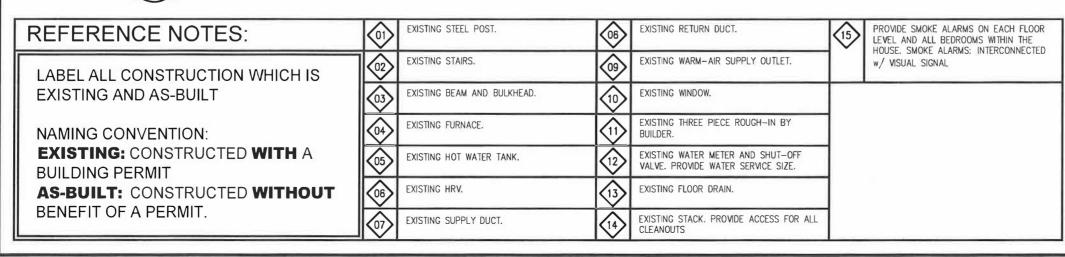

		A10	02
	PROJECT NO:	DRAWING NO:	
		FILE: TUDR_PLAN.DWG	
		SCALE: AS NOTED	
		DAYE: AUGUST 29, 20	118
OAMI LE LAIGHING BAGEMENT LAIN		CHECKED BY:	MINE
CHANGE OF USE - TWO UNIT HOUSE SAMPLE EXISTING BASEMENT PLAN		DRAWN BY: DG	X COMPLETE
PROJECT:		DESIGN BY: DG	DOC CONTROL DATE:

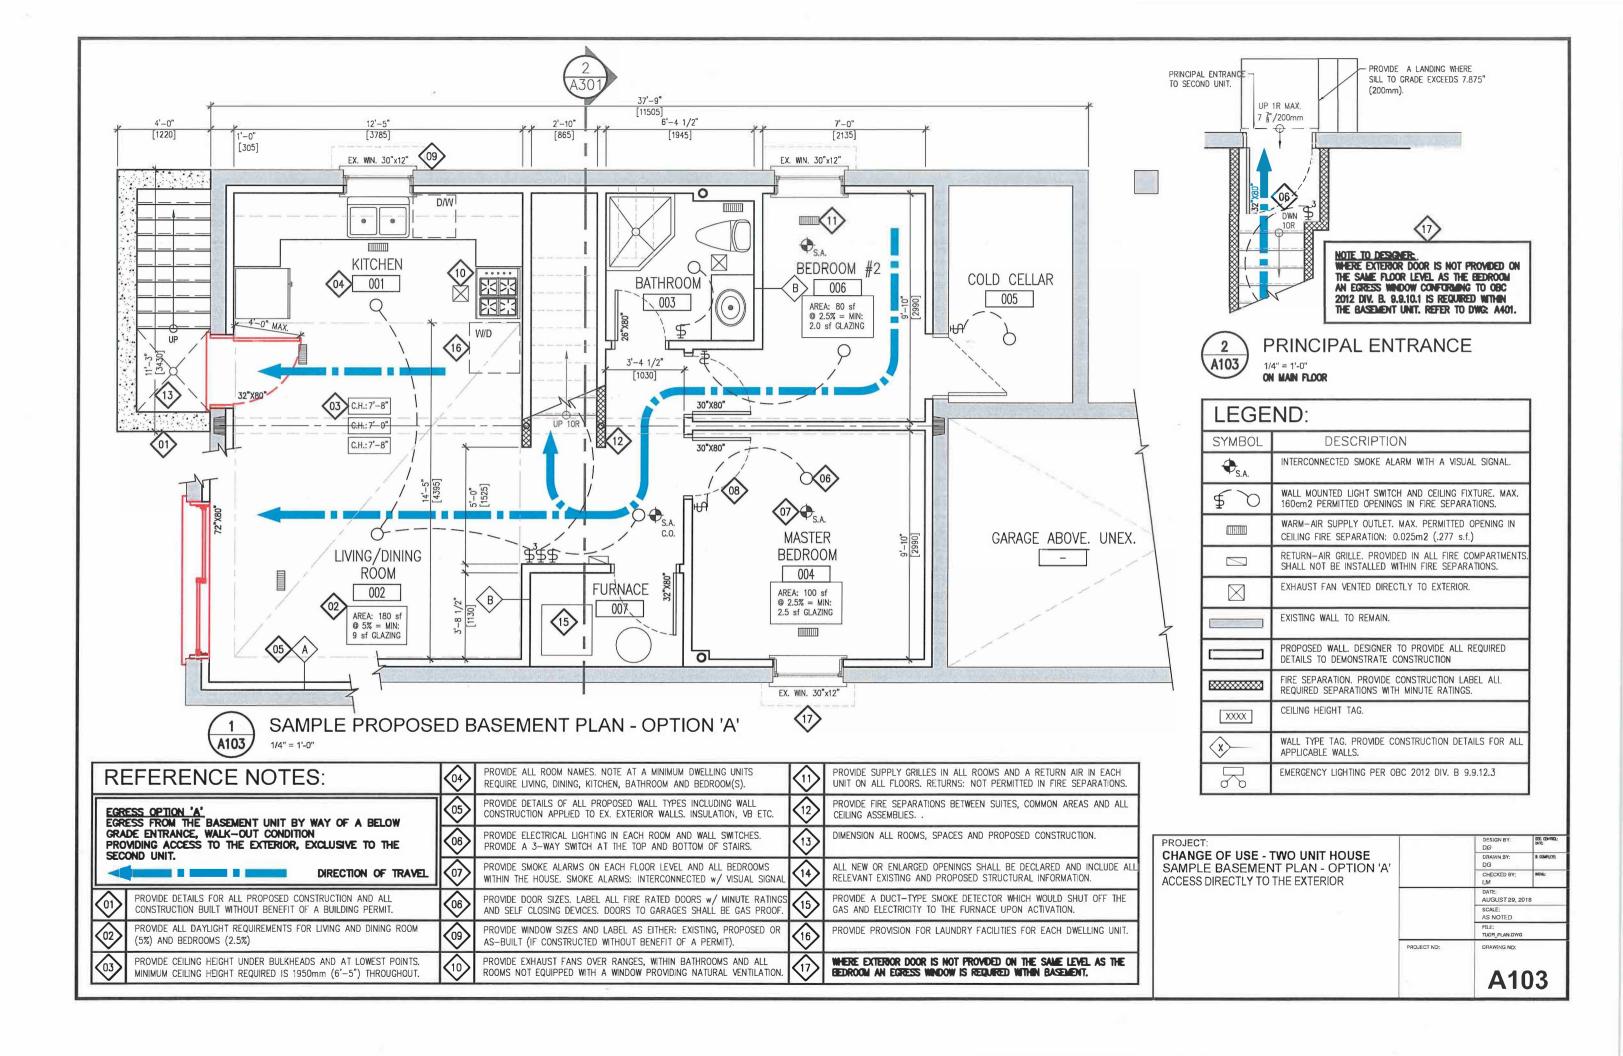

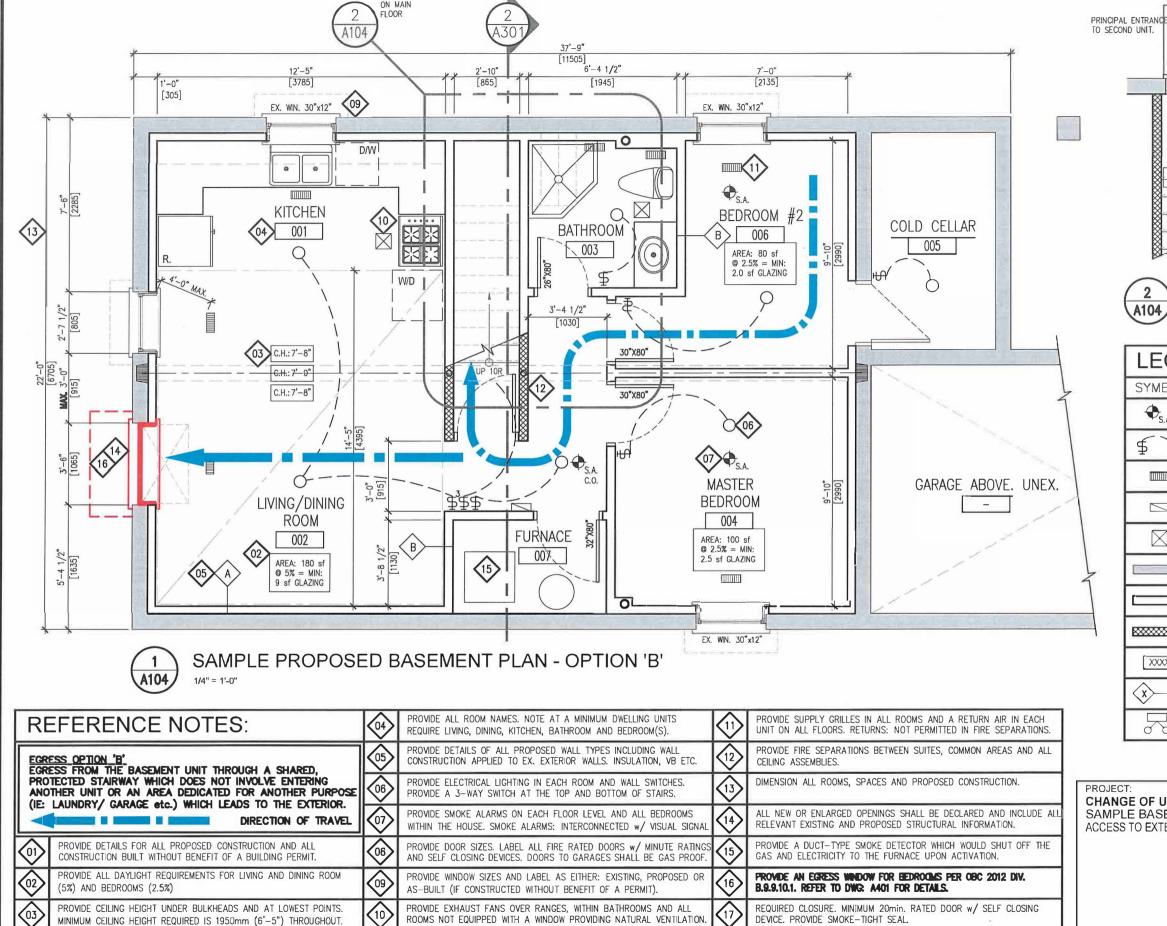

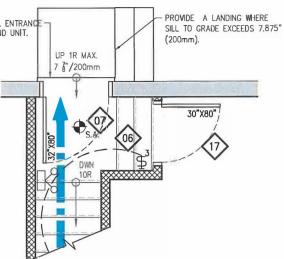





#### (SHARED MEANS OF EGRESS) PRINCIPAL ENTRANCE


1/4" = 1'-0" ON MAIN FLOOR

LEGEND:				
SYMBOL	DESCRIPTION			
◆ <sub>S.A.</sub>	INTERCONNECTED SMOKE ALARM WITH A VISUAL SIGNAL.			
\$0	WALL MOUNTED LIGHT SWITCH AND CEILING FIXTURE. MAX. 160cm2 PERMITTED OPENINGS IN FIRE SEPARATIONS.			
	WARM—AIR SUPPLY OUTLET. MAX. PERMITTED OPENING IN CEILING FIRE SEPARATION: 0.025m2 (.277 s.f.)			
	RETURN—AIR GRILLIE, PROVIDED IN ALL FIRE COMPARTMENTS. SHALL NOT BE INSTALLED WITHIN FIRE SEPARATIONS.			
$\boxtimes$	EXHAUST FAN VENTED DIRECTLY TO EXTERIOR.			
	EXISTING WALL TO REMAIN.			
	PROPOSED WALL. DESIGNER TO PROVIDE ALL REQUIRED DETAILS TO DEMONSTRATE CONSTRUCTION			
	FIRE SEPARATION. PROVIDE CONSTRUCTION LABEL ALL REQUIRED SEPARATIONS WITH MINUTE RATINGS.			
[XXXX]	CEILING HEIGHT TAG.			
<u>x</u>	WALL TYPE TAG. PROVIDE CONSTRUCTION DETAILS FOR ALL APPLICABLE WALLS.			
7	EMERGENCY LIGHTING PER OBC 2012 DIV. B 9.9.12.3			

PROJECT:		DESIGN BY: DG	DOC CONTROL: DATE:
CHANGE OF USE - TWO UNIT HOUSE SAMPLE BASEMENT PLAN - OPTION 'B'		DRAWN BY: DG	X COMPLETE
ACCESS TO EXTERIOR ON ANOTHER FLOOR		CHECKED BY: LM	MTA:
		DATE: AUGUST 29, 20	18
		SCALE: AS NOTED	
		FILE: TUDR_PLAN.DWG	
	PROJECT NO:	DRAWING NO:	
		A10	04

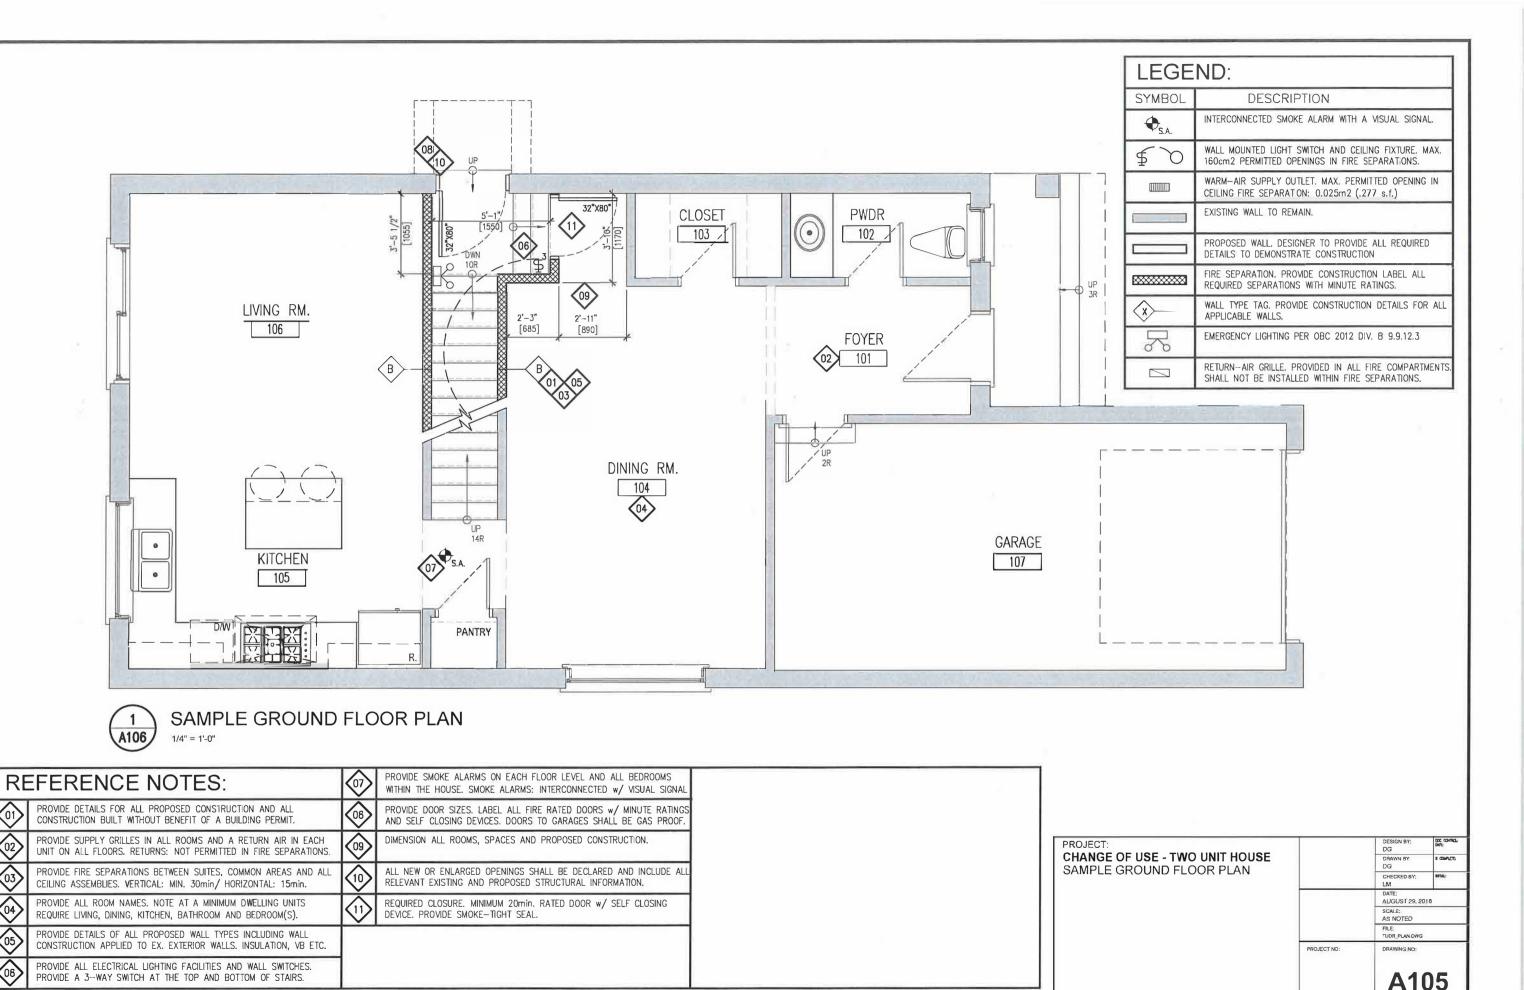

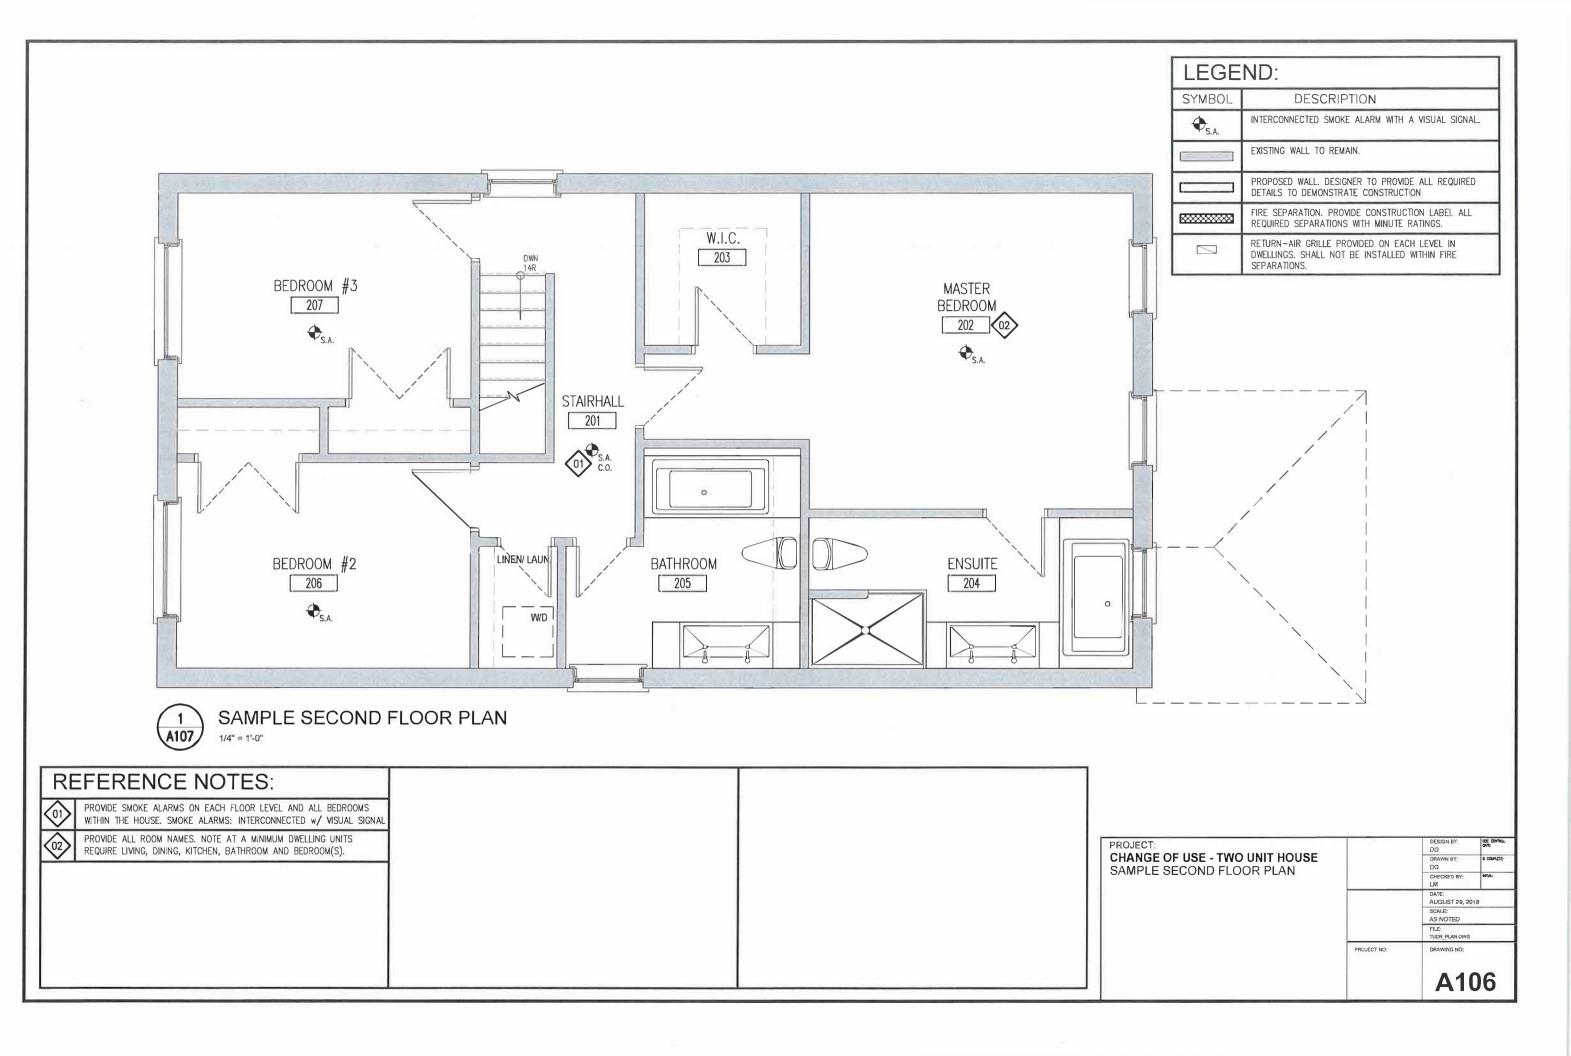

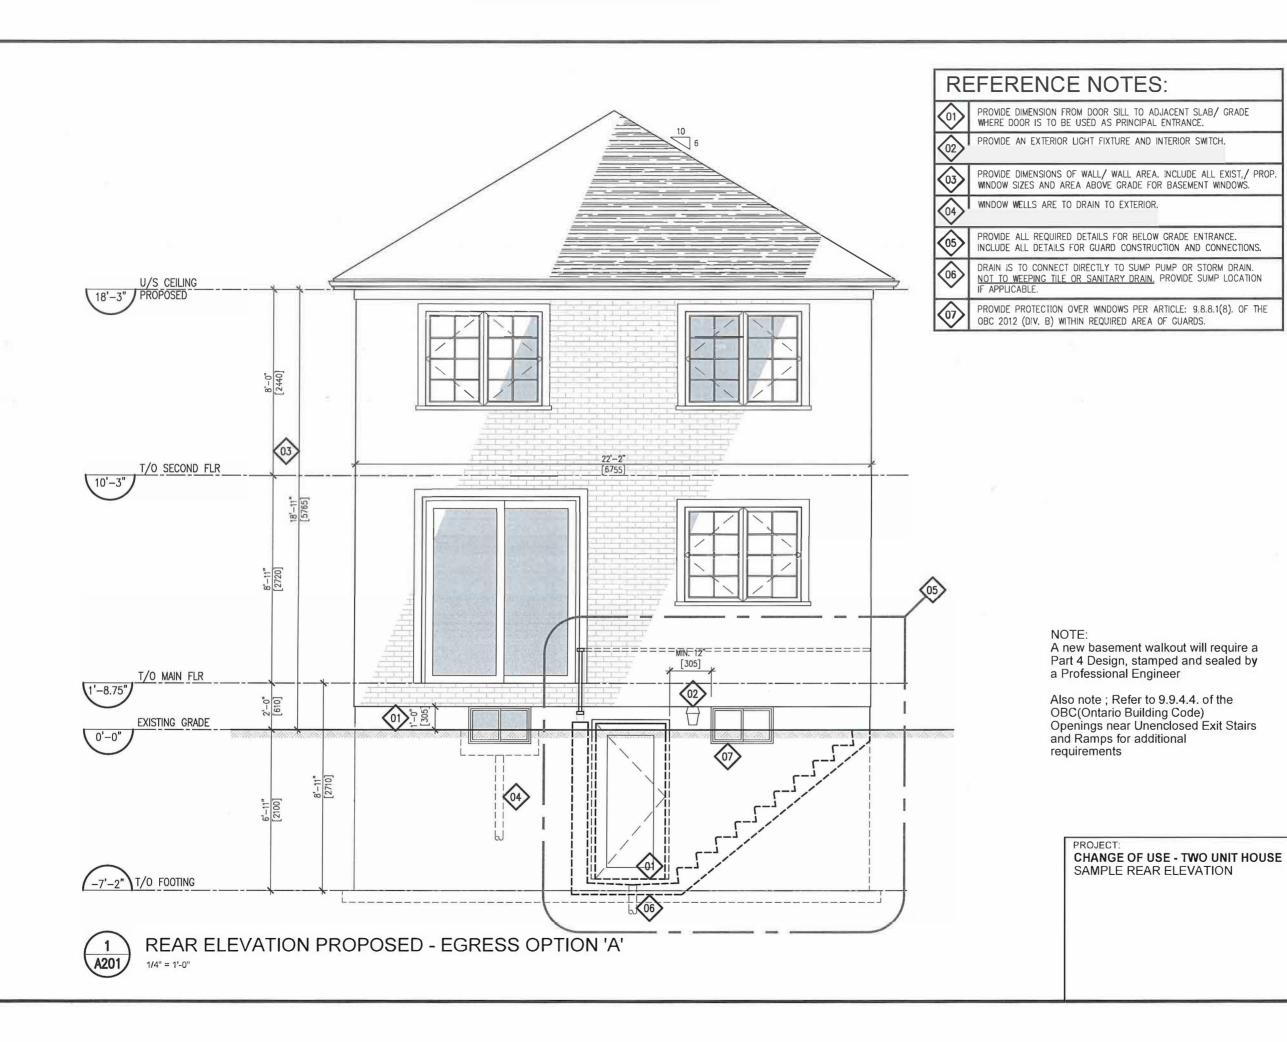



CHECKED BY:

PROJECT NO:

DATE: JANUARY 9th, 2019 SCALE: AS NOTED

A201

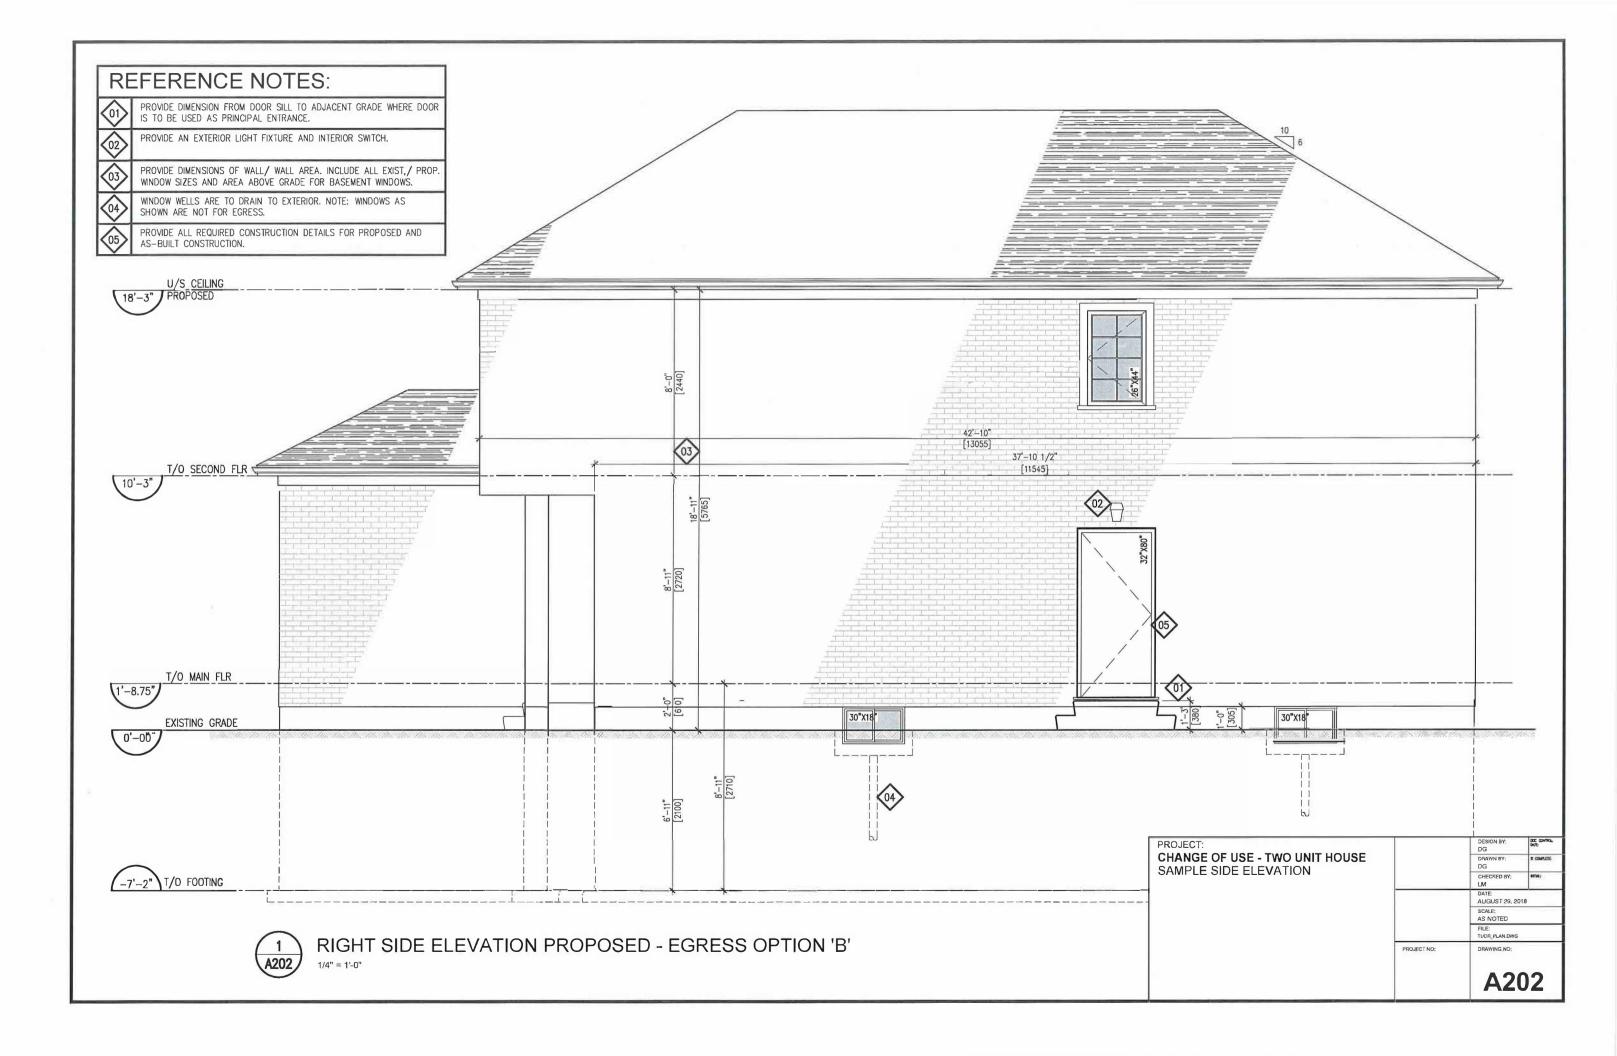


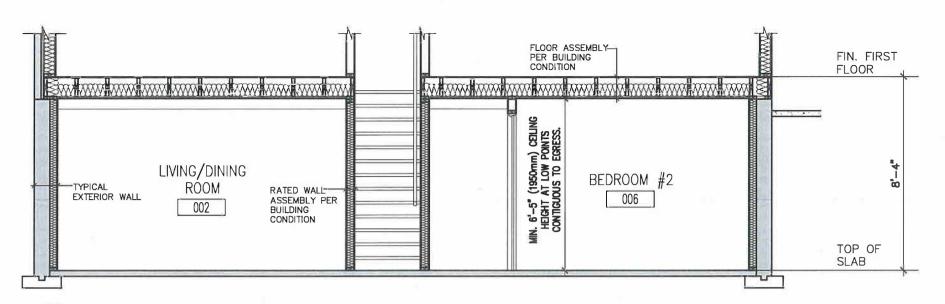



## **BASEMENT SECTION**

1/4" = 1'-0"

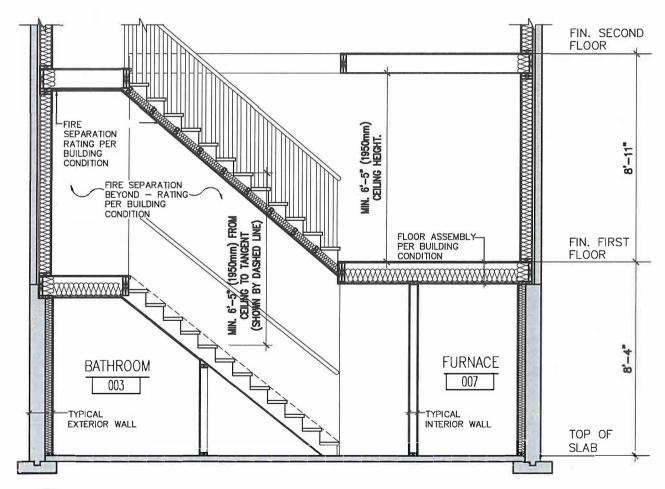



STAIR SECTION

1/4" = 1'-0"



2"x4" WOOD FRAMING 2 LAYERS TYPE 'X' GYPSUM BOARD RATING PER BUILDING CONDITION

STEEL BEAM SEPARATION




STEEL COLUMN SEPARATION 2"x4" WOOD STUDS
2 LAYERS TYPE 'X'
GYPSUM BOARD
RATING PER BUILDING
CONDITION



FIRE SEPARATION
CEILING ABOVE
2"x4" WOOD STUDS
1/2" GYPSUM BOARD


BULKHEAD BELOW FIRE SEPARATION

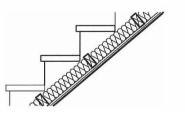

2"x4" WOOD STUDS TO SUPPORT CEILING SOUND INSULATION (OPTIONAL) 2 LAYERS TYPE 'X' GYPSUM BOARD RATING PER BUILDING CONDITION


# UNDERSIDE OF STAIR FIRE SEPARATION

PROJECT:		DESIGN BY: DS	DATE:
CHANGE OF USE - TWO UNIT HOUSE SAMPLE SECTIONS		DRAWN BY: DS	S COMPLETE
SAIVII LE SECTIONS		CHECKED BY:	NINE:
		DATE: AUGUST 29, 20	18
		SCALE: AS NOTED	
		FILE: TUDR_PLAN.DWG	
	PROJECT NO:	DRAWING NO:	
		A30	<b>1</b> 1

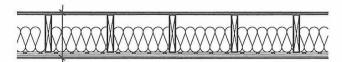

15.5mm PLYWOOD, OSB, OR
WAFERBOARD SUBFLOOR
WOOD JOISTS OR WOOD I—JOISTS
SPACED NOT MORE THAN 610mm O.C.
ABSORPTIVE MATERIAL IN CAVITY
RESILIENT CHANNELS @ 610mm O.C.
2 LAYERS 12.7mm TYPE 'X' GYPSUM BOARD

FLOOR ASSEMBLY F9h FRR - 45 MIN. STC - 53 BUILDING CONDITION A

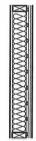


5/8" TYPE 'X' GYPSUM BOARD 2"x4" OR 2"x6" @ 16" O/C WOOD STUDS 3 1/2" SOUND INSULATION RESILIENT METAL CHANNELS @ 16" OR 24" O/C 2 LAYERS 5/8" TYPE 'X' GYPSUM BOARD

WALL ASSEMBLY W4a
FRR - 1 HOUR STC - 51
BUILDING CONDITION A




EXTERIOR FOUNDATION WALL 2"x4" OR 2"x6" @ 16" O/C WOOD STUDS
MIN. R12 BATT INSULATION
6 MIL. POLY VAPOUR BARRIER
1/2" GYPSUM BOARD

TYPICAL EXTERIOR WALL

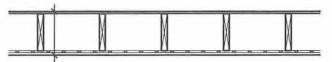

EXISTING PLYWOOD, OSB, OR
WAFERBOARD SUBFLOOR
WOOD JOISTS OR WOOD I—JOISTS
SPACED NOT MORE THAN 610mm O.C.
ABSORPTIVE MATERIAL IN CAVITY
(OPTIONAL 6" SOUND INSULATION)
RESILIENT CHANNELS @ 610mm O.C.
15.9mm TYPE 'X' GYPSUM BOARD

FLOOR ASSEMBLY F8d FRR - 30 MIN. STC - 43 BUILDING CONDITION B

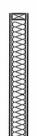


1/2" GYPSUM BOARD
2"x4" OR 2"x6" @ 16" O/C
WOOD STUDS
ENTIRE STUD CAVITY FILLED
WITH SOUND INSULATION
1/2" GYPSUM BOARD

WALL ASSEMBLY W1c FRR - 30 MIN. STC - N/A BUILDING CONDITION B (only permitted for existing wall, all new construction must meet STC 50)



1/2" GYPSUM BOARD
2"x4" OR 2"x6" @ 16" O/C
WOOD STUDS
ENTIRE STUD CAVITY FILLED
WITH SOUND INSULATION
(OPTIONAL)
1/2" GYPSUM BOARD

TYPICAL INTERIOR WALL

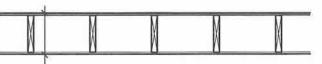


EXISTING SUBFLOOR
EXISTING WOOD JOISTS OR WOOD
I—JOISTS
NO ABSORPTIVE MATERIAL IN
CAVITY
12.7mm GYPSUM BOARD

EXISTING FLOOR ASSEMBLY FRR - 15 MIN. STC - N/A

(only permitted confirmation of 1/2" regular drywall was installed prior to 1995)

WALL TYPES DEMONSTRATED ON THIS DRAWING ARE BASED ON WALL CONSTRUCTION DETAILS SPECIFIED IN THE SUPPLEMENTARY STANDARD SB-3. DESIGNER IS REQUIRED TO SPECIFY THE MINUTE RATING AND CONSTRUCTION OF ALL REQUIRED FIRE SEPARATIONS.

PROJECT:		DESIGN BY: DS	DOC CONTROL: DATE:
CHANGE OF USE - TWO UNIT HOUSE WALL/ CEILING ASSEMBLIES		DRAWN BY: DS	S COMPLETE
WALL OLIENTO AGOLIVIDEILO		CHECKED BY: LM	BETINE:
		DATE: AUGUST 29, 20	18
		SCALE: AS NOTED	
		FILE: TUDR_PLAN.DWG	
	PROJECT NO:	DRAWING NO:	
			-
		A30	<b>J2</b>

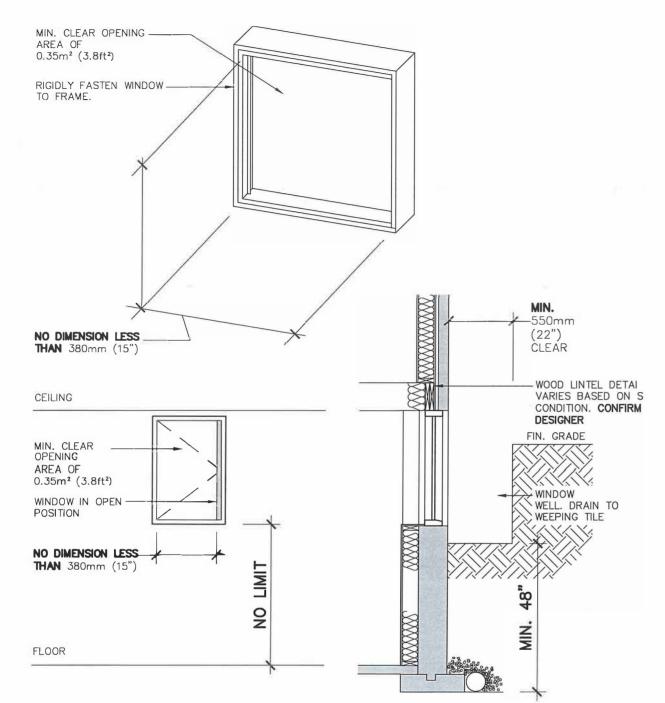

### NOTE:

Where a window required and opens into a window well, a clearance of not less than 550mm shall be provided in front of the window.

Where the sash of a window swings towards the window well, the operation of the sash shall not reduce the clearance in a manner that would restrict escape in an emergency. Where a protective enclosure is installed over the window well, such enclosure shall be openable from the inside without the use of keys, tools or special knowledge of the opening mechanism.


The max. depth of a window well - 0.6m


EGRESS WINDOW - OPTION 'A' or 'B'


3/8" = 1'-0"

**CHANGE OF USE - TWO UNIT HOUSE EGRESS WINDOW** 

	DS	DATE	
	DRAWN BY: DS	X COMPLETO	
	CHECKED BY:	DESAS	
CONSTRUCTION MORTH	DATE: JUNE 8th, 2019		
	SCALE: AS NOTED		
	FILE: TUOR_PLAN.DWG		
PROJECT NO:	DRAWING NO:		
		0.4	
	A40	<b>U1</b>	

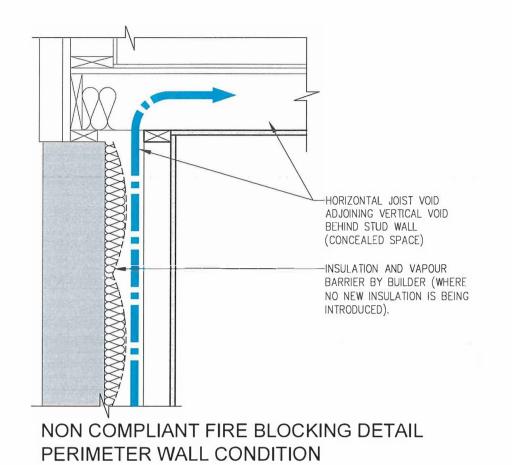

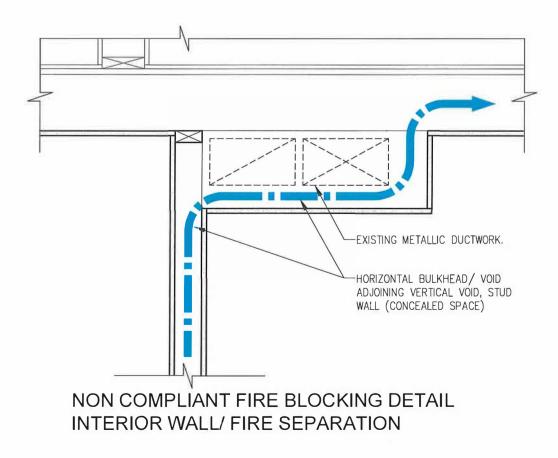

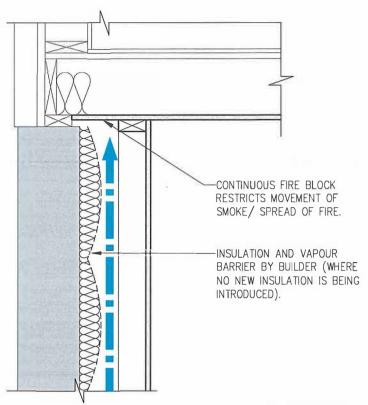


COMPLIANT FIRE BLOCKING DETAIL PERIMETER WALL CONDITION

## 9.10.16.1. REQUIRED FIRE BLOCKS IN CONCEALED SPACES:

- (1) CONCEALED SPACES IN INTERIOR WALLS, CEILINGS, FLOORS AND CRAWL SPACES SHALL BE SEPARATED BY FIRE BLOCKS FROM CONCEALED SPACES IN EXTERIOR WALLS AND ATTIC OR ROOF SPACES.
- (2) FIRE BLOCKS SHALL BE PROVIDED AT ALL INTERCONNECTIONS BETWEEN CONCEALED VERTICAL AND HORIZONTAL SPACES IN INTERIOR COVED CEILINGS, DROP CEILINGS AND SOFFITS WHERE THE EXPOSED CONSTRUCTION MATERIALS WITHIN THE CONCEALED SPACES HAVE A SURFACE FLAME—SPREAD RATING GREATER THAN 25.
- (3) FIRE BLOCKS SHALL BE PROVIDED AT THE TOP AND BOTTOM OF EACH RUN OF STAIRS WHERE THEY PASS THROUGH A FLOOR CONTAINING CONCEALED SPACE IN WHICH THE EXPOSED CONSTRUCTION MATERIALS WITHIN THE SPACE HAVE A SURFACE FLAMESPREAD RATING GREATER THAN 25.

MOVEMENT OF SMOKE/ SPREAD OF FIRE

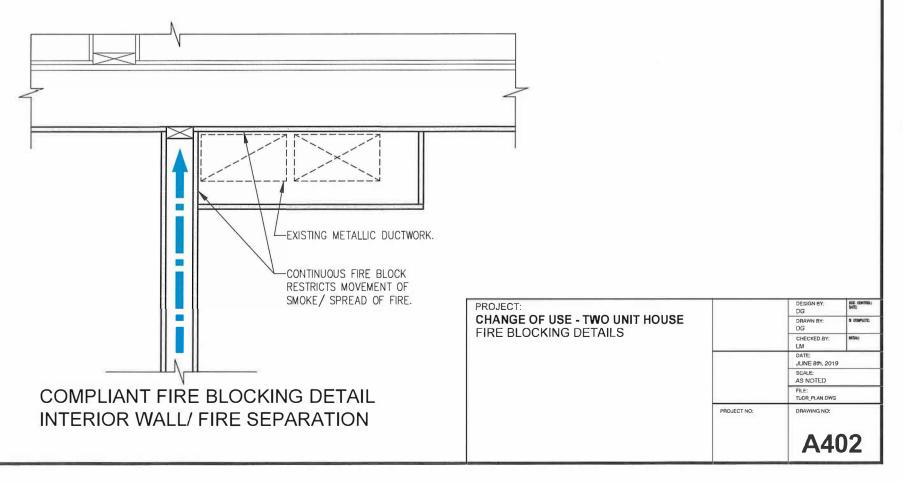

Access to Property Records within the Building Division may be requested using the online Property Records Search Application: https://www.hamilton.ca/propertyrecordsearch

Residential Building Permits (When do you need one and how do you apply for one): https://www.hamilton.ca/buildingpermits

Interactive Zoning Map:

https://www.hamilton.ca/city-planning/official-plan-zoning-by-law/interactive-zoning-mapping

Comprehensive Hamilton Zoning By-law No. 05-200 & to former Municipalities Zoning bylaws:

https://www.hamilton.ca/zoningbylaw05-200

https://www.hamilton.caformerzoningbylaws

Zoning Verification Certificate, used for purchasing or leasing a property, determining last recognized use, written response respecting a property's zoning and searches for open building permits, work orders, etc..

https://zoningverification.hamilton.ca

ePlans - Online Building Permit Applications:

https://hamilton.ca/eplans

	PROJECT NO:	DRAWING NO:	
		FILE: TUDR_PLAN.DWG	
		SCALE: AS NOTED	
		DATE: JUNE 8th, 2019	
		CHECKED BY: LM	MINE
Building Permit Applications		DRAWN BY: DG	S COMPLETE
PROJECT:		DESIGN BY: DG	DATE: